


50 NORTH-REFLECTED CEILING PLAN

SCALE IN FEET

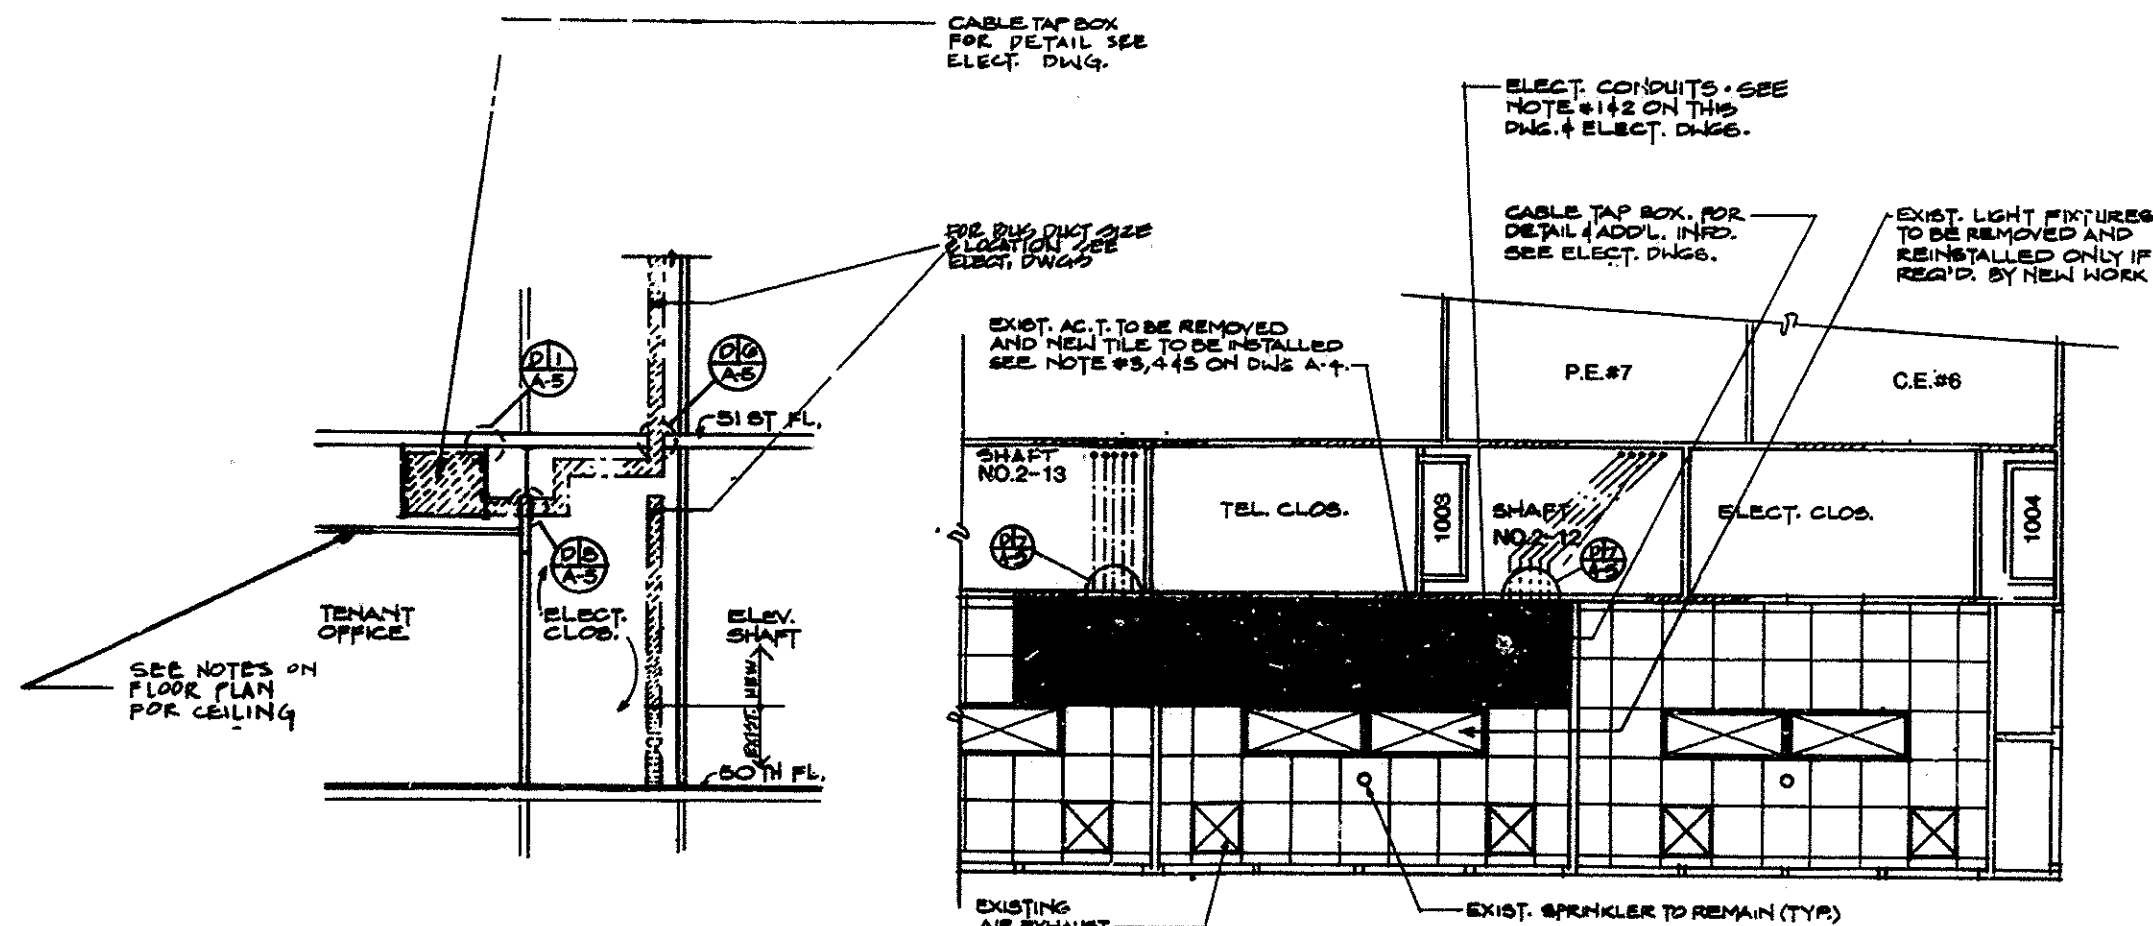

48 SOUTH-REFLECTED CEILING PLAN

SECTION


SCALE IN FEET

SCALE IN FEET

TYPICAL NOTES

1. FOR EXACT ELECTRICAL CONDUITS & BUS DUCT LOCATIONS AND DETAILS SEE ELECTRICAL DRAWINGS.
2. THE CONTRACTOR SHALL PROVIDE METAL BRACKETS AS REQUIRED TO HOLD IN PLACE THE ELECTRICAL CONDUITS TO WALLS AND CEILINGS.
3. THE CONTRACTOR SHALL REMOVE AND RESTORE PORTION OF EXISTING CEILING INCLUDING GRID/SHOWN ON DRAWINGS AS REQUIRED FOR THE INSTALLATION OF NEW ELECTRICAL WORK. ALL DAMAGED GRID SYSTEM, SUPPORTS AND DEFECTIVE SPLINE SHALL BE REPLACED AS REQUIRED. NEW A.C. TILE TO BE INSTALLED TO MATCH EXISTING MATERIAL IN TEXTURE, COLOR & TYPE AT THE CONTRACTOR'S EXPENSE.
4. THE CONTRACTOR SHALL ALIGN ALL THE REPLACED ACOUSTICAL TILE TO THE EXISTING TILES THAT REMAIN ON CONSTRUCTION AS SHOWN ON PLAN.
5. EXISTING LIGHT FIXTURES SHALL BE REMOVED AND RE-INSTALLED. SEE LIGHT FIXTURE LEGEND ON DWG. 8A-3. SEE ELECTRICAL DWGS FOR INSTALLATION.

SEE DWG. A-3 FOR LIGHT FIXTURE LEGEND

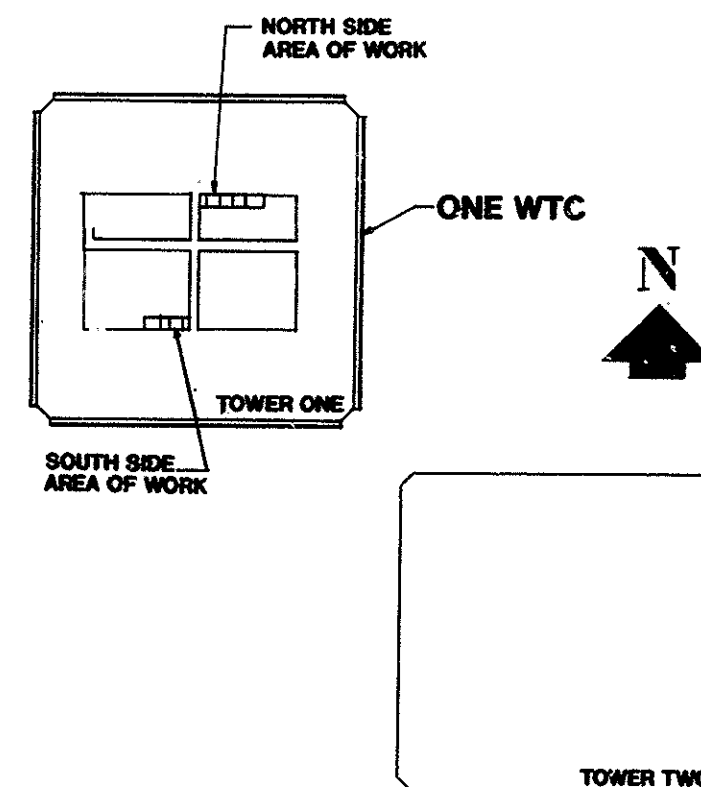


KEY PLAN
NO SCALE

Sheet 7 of 41

**THE PORT AUTHORITY
OF NY & NJ**

James J. Spon
Engineering Program Manager

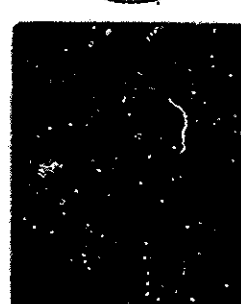

3/15/01 Drawings of Record
No. Date Revision Approved

Engineering Department
Design Division

**The World Trade
Center
Electrical/HVAC
Upgrade Program**

Title
LOW VOLTAGE DISTRIBUTION

**ONE WTC
ARCHITECTURAL
48TH FLOOR
SOUTH SIDE
50TH FLOOR
NORTH SIDE**

**REFLECTED CEILING
PLANS & SECTION**

This drawing subject to conditions in contract. All inventions, ideas, designs and methods herein are reserved to Port Authority and may not be used without its written consent.

S.C.A.M.S. S.C.A.S.P.P.
Designed by Drawn by Checked by

Date 10-4-93 Scale AS NOTED

Contract Number Drawing Number

WTC-804.041 A-4